Washoe County Development Application

Your entire application is a public record. If you have a concern about releasing personal information, please contact Planning and Building staff at 775.328.6100.

Project Information	S	Staff Assigned Case No.:	
Project Name: Fuselier Inhaw Quarters			
Project Description: DADAR			
Project Address: 6275 Bock Farm Drive			
Project Area (acres or square feet): 2,5 acres			
Project Location (with point of reference to major cross streets AND area locator):			
Timberline x	Rock Farm	Road	
Assessor's Parcel No.(s):	Parcel Acreage:	Assessor's Parcel No.(s):	Parcel Acreage:
049-040-08	2.5		
	e County approval	s associated with this applicat	tion:
		additional sheets if necess	sary)
Property Owner:	and a state of the	Professional Consultant:	Control of the Contro
Name: Jean Fusco	lier	Name:	
Address: 609 Mogb Ot		Address:	
Beno NV Zip: 89523		Zip:	
Phone: 7-75-527-314 T ax:		Phone: Fax:	
Email: fuselier jean o	700 @ gmail, con	Email:	
Cell: 775-527-3142	Other:	Cell:	Other:
Contact Person: Jean Fr		Contact Person:	and the second s
Applicant/Developer:		Other Persons to be Contact	ed:
Name:		Name: LOR; Fuselier	
Address:		Name: LOR; FUSE Ser Address: 1680 Back Nine Trail	
Zip:		Rieno NV Zip: 89523	
Phone: Fax:		Phone: 775-527-3142Fax:	
Email:		Email: Jori fusclier @ gmail Com	
Cell: Other:		Cell:	Other:
Contact Person:		Contact Person: Lori L	or, fuselier Quahoc
For Office Use Only			
Date Received: Initial:		Planning Area:	
County Commission District:		Master Plan Designation(s):	
CAB(s):		Regulatory Zoning(s):	

Special Use Permit Application Supplemental Information

(All required information may be separately attached)

1. What is the project being requested?

INLAW QUALTERS - DADAR -ZERPROBM, 2BATH, 2 CHE GALLER

2. Provide a site plan with all existing and proposed structures (e.g. new structures, roadway improvements, utilities, sanitation, water supply, drainage, parking, signs, etc.)

INCLUPED

3. What is the intended phasing schedule for the construction and completion of the project?

START THE SURMET OF 2023

4. What physical characteristics of your location and/or premises are especially suited to deal with the impacts and the intensity of your proposed use?

THE LOT IS BIG, 2.5 ACRES, THERE IS A LOT OF SPACE FOR THE EXTRA HOUSE. IT WILL BE A MOTHER INLAW QUALTERS.

5. What are the anticipated beneficial aspects or affects your project will have on adjacent properties and the community?

IT WILL PRATENTAL EXISTING HOUSE WITH SIDING, 7004 SLOPE AND POOPING.

6. What are the anticipated negative impacts or affect your project will have on adjacent properties? How will you mitigate these impacts?

I AM NOT SURE OF THE HEGATIVE IMPACTS ON

7. Provide specific information on landscaping, parking, type of signs and lighting, and all other code requirements pertinent to the type of use being purposed. Show and indicate these requirements on submitted drawings with the application.

HOUSE IS BULLT. TYPICAL HOUSE LIGHTS.

D V			NI		
☐ Yes	and some sets of the second		No		
tilities:					
a. Sewer Service		SKPTIC			
b. Electrical Service		NU KNAZGY			
c. Telephone Service		NONE			
d. LPG or Natural Gas Service		PROPHOLE			
e. Solid Waste Disposa	al Service	WASTE MANAGEMENT			
f. Cable Television Se	rvice	None			
g. Water Service		wkl			
i. Certificate # j. Surface Claim #			acre-feet per year acre-feet per year		
			ts to Washoe County. d dedication be required		
h. Permit #			acre-feet per year		
k. Other #			acre-feet per year		
itle of these violate (se	s nied with	the State Engin	eer in the Division of	vvater Resources of th	
		atural Resources)			
Fitle of those rights (as Department of Conserva Community Services (pre	ation and Na				
Department of Conserva	ation and Na	nearest facility):	THADOWS FIRE		
Department of Conserva Community Services (pre	ation and Na	nearest facility):	THADOWS FIRE		
Department of Conserva Community Services (pro	ovided and	nearest facility):	TRADOWS FIRE		
Community Services (pro a. Fire Station b. Health Care Facility c. Elementary School	ovided and	nearest facility): THUCKER I CAFE MER	TRADOWS FIRE		
Department of Conserva Community Services (pro a. Fire Station b. Health Care Facility	ovided and	nearest facility): THUCKER I CAFE MER	TRADOWS FIRE		
Community Services (pro a. Fire Station b. Health Care Facility c. Elementary School d. Middle School e. High School	ovided and	nearest facility): THUCKER I CAFR MER UNSBERGER HELZ ALRNA	TRADORS FIRE		
Community Services (proceed) a. Fire Station b. Health Care Facility c. Elementary School d. Middle School e. High School	ovided and	nearest facility): THUCKER I CAFR MER UNSBERGER HELZ ALRNA	TRADOWS FIRE		

Special Use Permit Application for Grading Supplemental Information

(All required information may be separately attached)

1.	What is the purpose of the grading?				
2.	How many cubic yards of material are you proposing to excavate on site?				
3.	How many square feet of surface of the property are you disturbing?				
4.	How many cubic yards of material are you exporting or importing? If none, how are you managing to balance the work on-site?				
5.	Is it possible to develop your property without surpassing the grading thresholds requiring a Special Use Permit? (Explain fully your answer.)				
6.	Has any portion of the grading shown on the plan been done previously? (If yes, explain the circumstances, the year the work was done, and who completed the work.)				
7.	Have you shown all areas on your site plan that are proposed to be disturbed by grading? (If no, explain your answer.)				

		perties also be served by the proposed access/grading requested (i.e. if you would it be used for access to additional neighboring properties)?
		zontal/vertical) of the cut and fill areas proposed to be? What methods will until the revegetation is established?
Are you	planning any b	erms?
,	NI	
If your p		high will the walls be and what is their construction (i.e. rockery, concre
If your prequired	oroperty slopes ? If so, how nanufactured b	s and you are leveling a pad for a building, are retaining walls going to high will the walls be and what is their construction (i.e. rockery, concre
required' timber, n	roperty slopes If so, how nanufactured be	s and you are leveling a pad for a building, are retaining walls going to high will the walls be and what is their construction (i.e. rockery, concrelock)?

16.	How are	you providing	g temporary irrigation to the disturbed area?
17.			e revegetation plan with the Washoe Storey Conservation District? If yes, have suggestions?
18.		e any restric	tive covenants, recorded conditions, or deed restrictions (CC&Rs) that may grading?
	Yes	No	If yes, please attach a copy.

Special Use Permit Application for Stables Supplemental Information (All required information may be separately attached)

1.	What is the maximum number of horses to be boarded, both within stables and pastured?
2.	What is the maximum number of horses owned/maintained by the owner/operator of the project, both within stables and pastured?
3.	List any ancillary or additional uses proposed (e.g., tack and saddle sales, feed sales, veterinary services, etc.). Only those items that are requested may be permitted.
4.	If additional activities are proposed, including training, events, competition, trail rides, fox hunts, breaking, roping, etc., only those items that are requested may be permitted. Clearly describe the number of each of the above activities which may occur, how many times per year and the number of expected participants for each activity.
5.	What currently developed portions of the property or existing structures are going to be used with this permit?
6.	To what uses (e.g., restrooms, offices, managers living quarters, stable area, feed storage, etc.) will the barn be put and will the entire structure be allocated to those uses? (Provide floor plans with dimensions).
7.	Where are the living quarters for the operators of the stables and where will employees reside?

8.	How many improved parking spaces, both on-site and off-site, are available or will be provided? (Please indicate on site plan.) Have you provided for horse trailer turnarounds?				
9.	What are the planned hours of operation?				
10.	What improvements (e.g. new structures including the square footage, roadway/driveway improvements, utilities, sanitation, water supply, drainage, parking, signs, etc.) will have to be constructed or installed and what is the projected time frame for the completion of each?				
11.	What is the intended phasing schedule for the construction and completion of the project?				
12.	What physical characteristics of your location and/or premises are especially suited to deal with the impacts and the intensity of your proposed use?				
13.	What are the anticipated beneficial aspects or affects your project will have on adjacent properties and the community?				
14.	What are the adverse impacts upon the surrounding community (including traffic, noise, odors, dust, groundwater contamination, flies, rats, mice, etc.) and what will you do to minimize the anticipated negative impacts or effects your project will have on adjacent properties?				
15.	Please describe operational parameters and/or voluntary conditions of approval to be imposed on the administrative permit to address community impacts.				

16.	What types of landscaping (e.g. shrubs, trees, fe indicate location on site plan.)	ncing, painting scheme, etc.) are proposed? (Please			
17.	What type of signs and lighting will be provided? On a separate sheet, show a depiction (height, width, construction materials, colors, illumination methods, lighting intensity, base landscaping, etc.) of each sign and the typical lighting standards. (Please indicate location of signs and lights on site plan.)				
18.	Are there any restrictive covenants, recorded conditions, or deed restrictions (CC&Rs) that apply to the area subject to the administrative permit request? (If so, please attach a copy.)				
	☐ Yes	□ No			
19.	Community Sewer				
	☐ Yes	□ No			
20.	Community Water				
	☐ Yes	□ No			

From: <u>Lori Fuselier</u>

To: <u>Bronczyk, Christopher</u>

Cc: fuselierjean0700@gmail.com; Lori Fuselier

Subject: Fw: Fuselier Inlaw DADAR Application

Date: Monday, March 13, 2023 5:52:28 PM

Attachments: <u>image001.png</u>

[NOTICE: This message originated outside of Washoe County -- DO NOT CLICK on links or open attachments unless you are sure the content is safe.]

Hello Christopher,

I hope this email finds you well. As I understand it you need confirmation of square footage for the following

Square Footage of Proposed Home

- Living Space 3774 SF
- Garage: 1198 SF

Square Footage of Proposed In-law Quarters (which is the home I would occupy)

- Living Space -1500 SF
- Garage 519.80 SF

Please feel free to call or email me if you have further questions.

Regards.

Lori Fuselier 775-813-6840

---- Forwarded Message -----

From: Jean Fuselier <fuselierjean0700@gmail.com>
To: "lorifuselier@yahoo.com" <lorifuselier@yahoo.com>
Sent: Monday, March 13, 2023 at 05:09:17 PM PDT
Subject: Fwd: Fuselier Inlaw DADAR Application

----- Forwarded message ------

From: Bronczyk, Christopher < CBronczyk@washoecounty.gov>

Date: Mon, Mar 13, 2023 at 5:03 PM Subject: Fuselier Inlaw DADAR Application

To: fuselierjean0700@gmail.com <fuselierjean0700@gmail.com>

Hi Jean,

Thank you for taking my call, as mentioned I just need clarification on the square footages.

Can you provide me the following.

Square Footage of Proposed Home

- Living Space
- Garage

Square Footage of Proposed Inlaw Quarters

- Living Space
- Garage

What I have on file from the plans for the submittal is: 3774 SF Home with a 1,198 sf Garage; 1,500 sf inlaw quarters with a 506sf garage.

I need something in writing from the applicant however outlining the proposed square footage of everything.

Thank you,



Chris Bronczyk

Senior Planner, Planning & Building Division | Community Services Department

cbronczyk@washoecounty.gov | Direct Line: 775.328.3612

My working hours: Monday-Friday 7:00am to 3:30pm


Visit us first online: www.washoecounty.gov/csd


Planning Division: 775.328.6100 | Planning@washoecounty.gov

CSD Office Hours: Monday-Friday 8:00am to 4:00pm

1001 East Ninth Street, Reno, NV 89512

A New Inlaw Quarters Lori & Jean Luselier

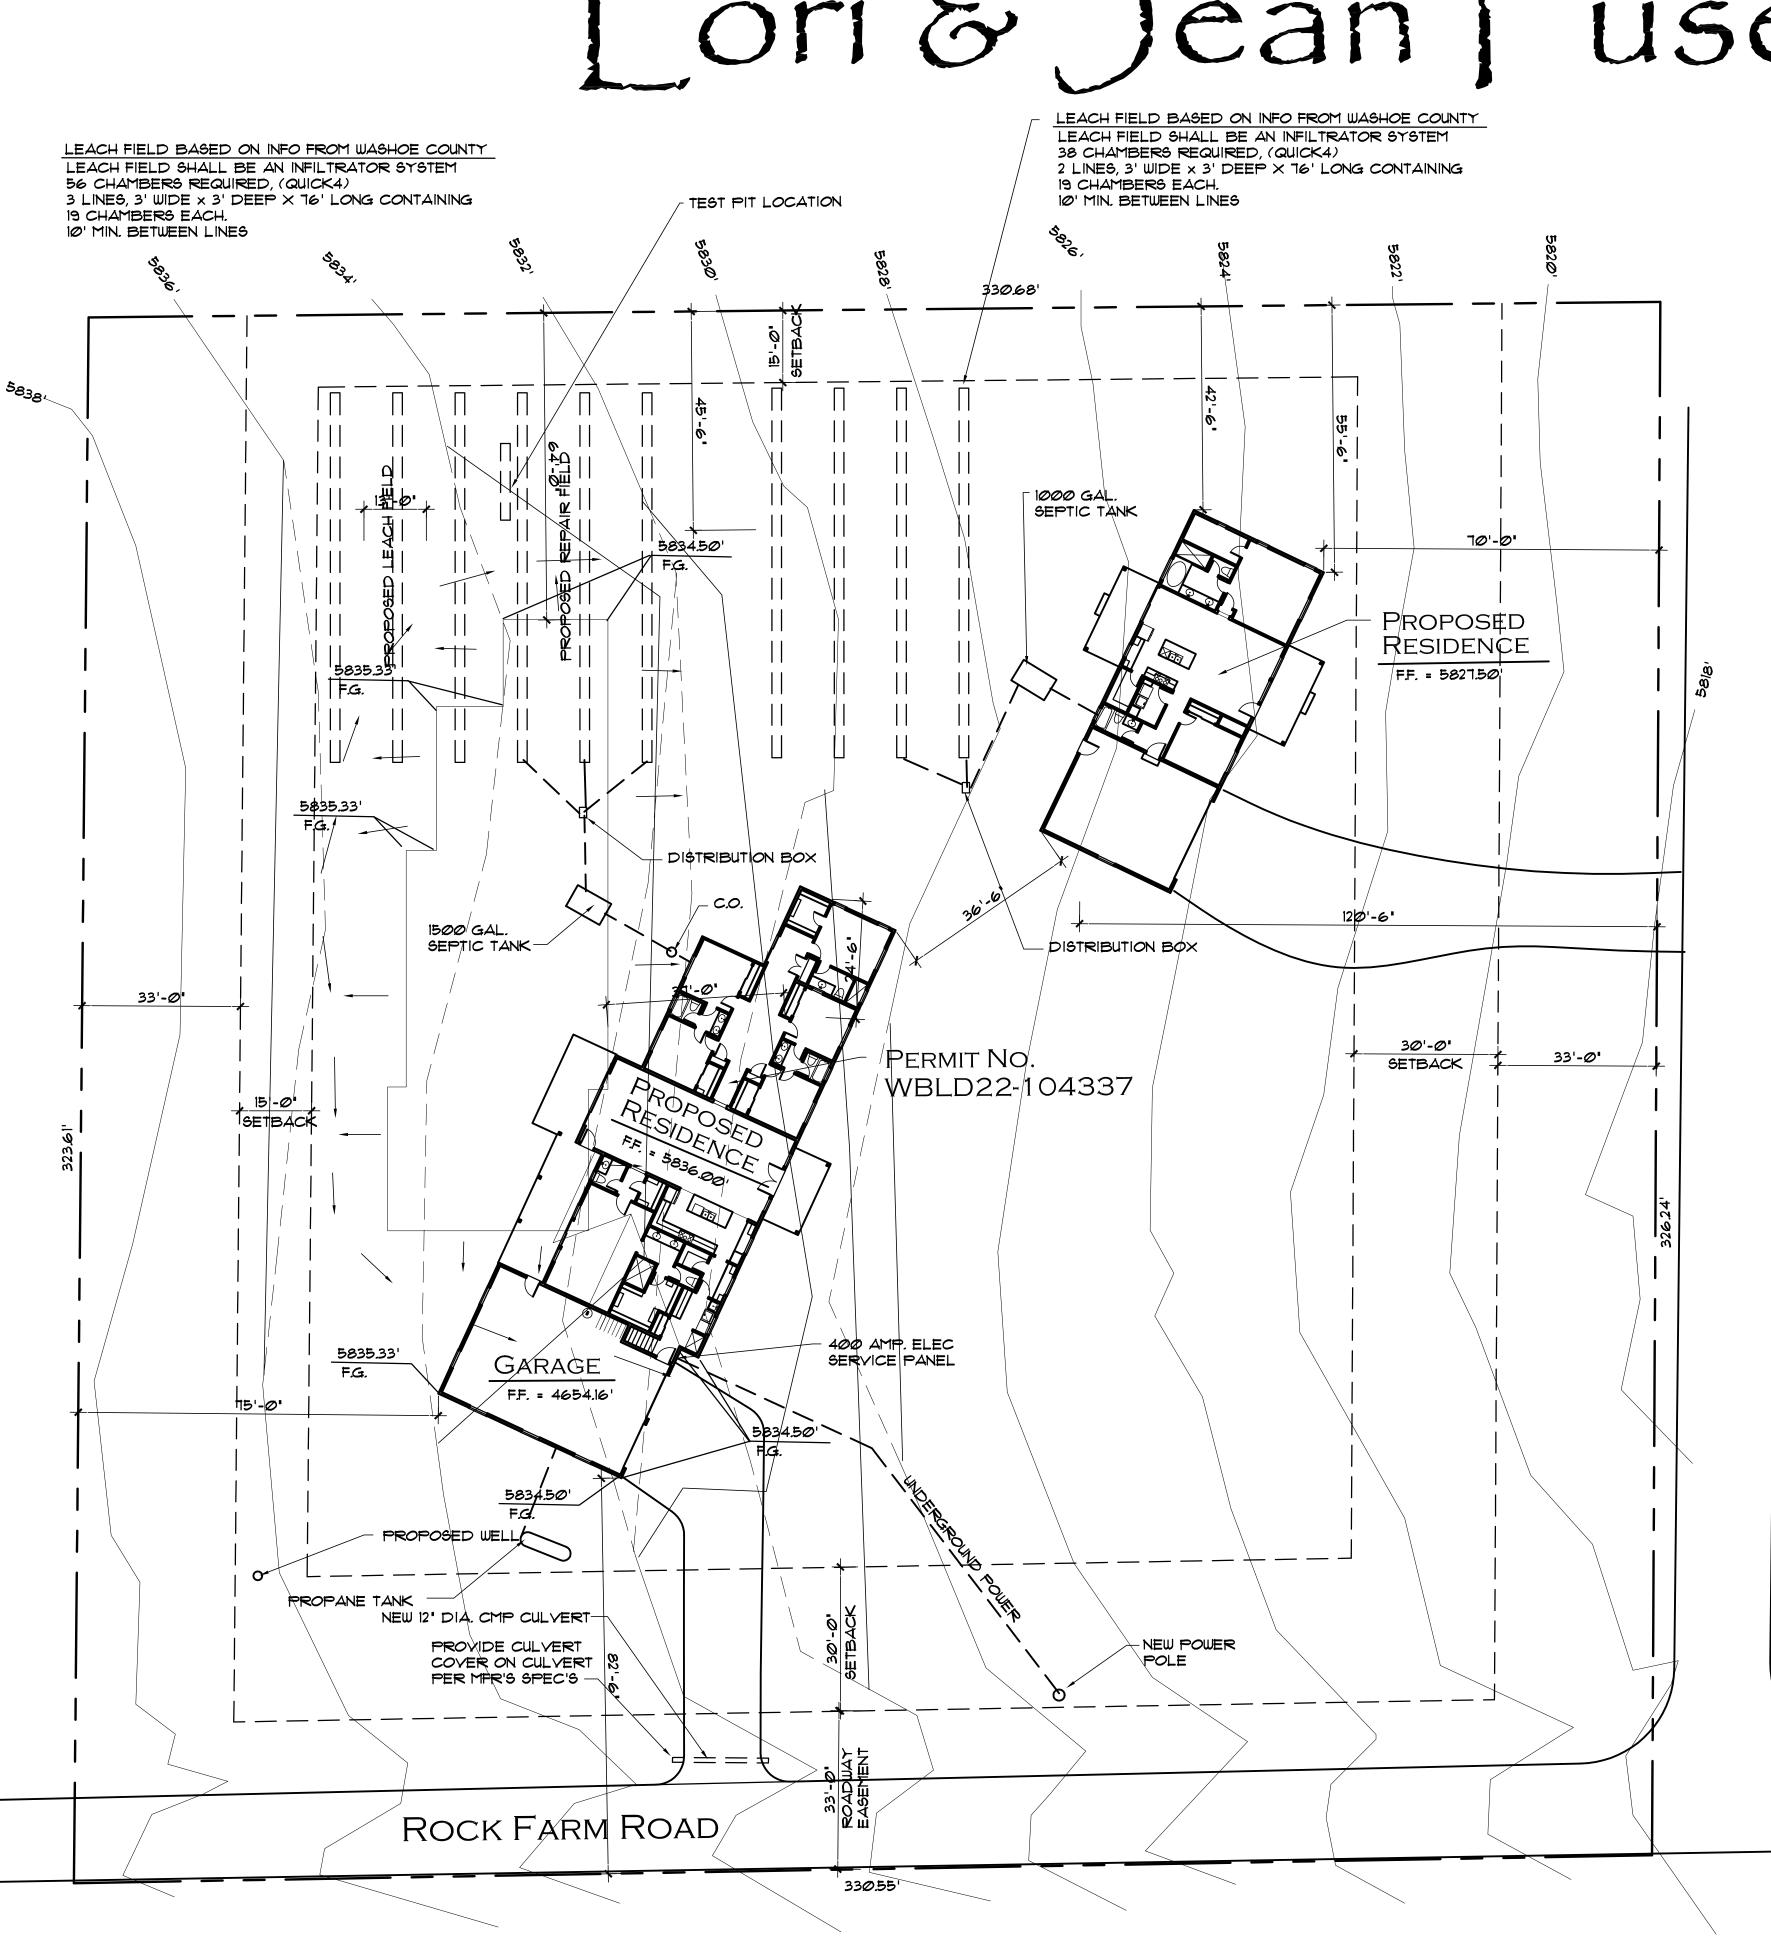

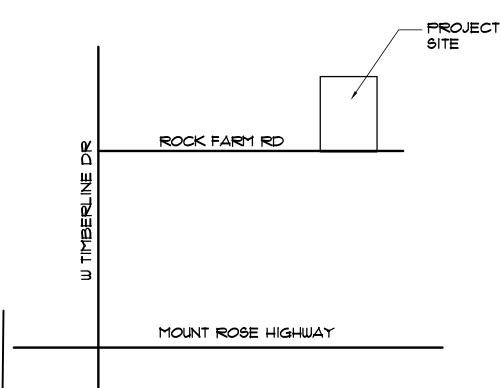

VICINITY MAP

WUI NOTES

- ACCESS DOES COMPLY WITH SECTION 402.2 AND 402.2.1 2. WATER SUPPLY DOES NOT CONFORM TO 402.2, EXCEPTION WILL BE USED FOR NON-CONFORMING WATER SUPPLY.
- IR2 CONSTRUCTION (1.5 XDEFENSIBLE SPACE.) 3. DEFENSIBLE SPACE SHALL BE 15' FROM HOUSE AND SHALL BE CLEARED OF ALL BRUSH AND MAINTAINED. TREES ARE ALLOWED IN THE DEFESIBLE SPACE PROVIDED THE HORIZ. DISTANCE BETWEEN THWE CROWNS OF ADJACENT TREES AND CROWNS OR TREES AND STRUCTURES, OVERHEAD ELECTRICAL FACILITIES AND UNMODIFIED FUEL IS NOT LESS THAN 10'-0"

GRADING NOTES

4800 s.f. **CUT AREA** 250 C.Y. **CUT QUANTITY** 4400 s.f. FILL AREA 250 C.Y. FILL QUANTITY DISTURBED AREA 9200 S.F.

GRADING NOTES:

- 1. CONTRACTOR TO PERPETUATE EXISTING DRAINAGE TO THE STREET. DRAINAGE SHALL NOT CHANGE FROM EXISTING CONDITIONS. 2. SLOPE FINISH GRADE AWAY FROM
- HOUSE AT 5% MIN. FOR 10'-0" MIN. 3. PROVIDE LANDSCAPING AS REQUIRED TO STABALIZE THE AREAS DISTURBED BY CONSTRUCTION.
- 4. MAXIMUM SLOPE OF GRADE SHALL BE 3:1.

THESE PLANS HAVE BEEN PREPARED IN ACCORDANCE WITH CONDITIONS OF APPROVAL AND COUNTY CODE.

ALL IMPROVEMENTS WITHIN THE COUNTY RIGHT-OF-WAY SHALL BE CONSTRUCTED IN ACCORDANCE WITH THE LATEST COUNTY CODES AND THE LATEST COUNTY STANDARD SPECIFICATIONS AND DETAILS.

CONSULTANTS

RESIDENTIAL DESIGNER MICHAEL T. PETERSON 3710 GRANT DRIVE SUITE C RENO NEVADA 89509 PHONE: (775) 856-1400 CELL: (775) 240-4564 MIKE@MTPETERSON.COM ENGINEER

K2 Engineering 860 MAESTRO DRIVE SUITE A Reno, Nevada 89511 PHONE: (775) 355-0505 JARED@K2ENG.NET

OWNER INFORMATION

JEAN & LORI FUSELIER 14437 RAIDER RUN ROAD BEND, OREGON 97703 PHONE (775) 527-3142

DESIGN INFORMATION

2018 I.R.C. RESIDENTIAL CODE 2018 I.R.C. ELECTRICAL CODE 2018 I.R.C. PLUMBING CODE 2018 I.R.C. MECHANICAL CODE **ENERGY CONS. CODE** 2018 IECC 2018 I.B.C. STRUCTURAL DESIGN VULT 130 MPH EXP C Wind Load SEISMIC ZONE D-2 87 PSF SNOW Roof LL WUI FIRE ZONE HIGH

GENERAL NOTES

IN THE FIELD. ALL QUESTIONS AS TO DIMENSIONS AND FIELD CONDITIONS SHALL BE RESOLVED BEFORE THE AFFECTED WORK PROCEEDS.

AND ANY APPLICABLE LOCAL ORDINANCES WHICH AFFECT THIS PROJECT

- THE GENERAL BUILDING PERMIT AND PLAN CHECK FEE SHALL BE SECURED AND PAID FOR BY THE OWNER. ALL OTHER LICENSES AND FEES SHALL BE OBTAINED BY THE APPLICABLE TRADE CONTRACTOR FOR THE ASPECTS OF THE WORK RELATED TO THEIR TRADE.
- THE BUILDER SHALL BE RESPONSIBLE FOR PROVIDING AND MAINTAINING TEMPORARY WATER SUPPLY, LIGHT / POWER, TOILET FACILITIES, AND A
- ALL TRADES SHALL AT ALL TIMES, KEEP THE PREMISES FREE FROM ACCUMULATION OF WASTE MATERIALS OR RUBBISH CAUSED BY THEIR WORK, AND AT THE COMPLETION OF THEIR WORK REMOVE ALL RUBBISH FROM AND ABOUT THE JOB SITE, AND ALL THEIR TOOLS, SCAFFOLDING AND SURPLUS MATERIALS, AND SHALL LEAVE THE JOB BROOM CLEAN, INCLUDING REMOVING ALL LABELS, STICKERS, PAINT SMEARS, ETC. FROM LIGHTING FIXTURES, PLUMBING FIXTURES, GLASS SURFACES, FINISH HARDWARE, CABINETS, COUNTER TOPS, ETC.
- NOTHING INDICATED ON THESE PLANS IS INTENDED TO CONFLICT WITH ANY APPLICABLE CODE OR ORDINANCE. IN THE EVENT OF A CONFLICT THE CONTRACTOR OR SUB CONTRACTOR SHALL NOTIFY THE ARCHITECT PRIOR TO PROCEEDING WITH THE AFFECTED WORK

EXISTING 840 SQ. FT RESIDENCE TO BE TRANSITIONED TO 840 SQ. FT DADU AS PER ARTICLE 302 \$ 306

RESIDENCE INFORMATION

3437 Sq. Ft. FIRST FLOOR LIVING AREA SECOND FLOOR LIVING AREA 337 SQ. FT. TOTAL LIVING AREA 3774 Sq. Ft. 1198 Sq. Ft. GARAGE AREA 425 Sq. FT. COVERED PORCH AREA


BUILDING INFORMATION

BUILDING OCCUPANCY GROUP: IRC TYPE OF CONSTRUCTION VΒ A. P. N.: 049 - 040 - 08 LOT SIZE 2.5 ACRES Lot: BLOCK:

SHEET SCHEDULE

SUB DIVISION: UNSPECIFIED

- A-1 COVER SHEET & SITE PLAN
- FLOOR PLANS
- EXTERIOR ELEVATIONS
- **BUILDING SECTIONS**
- ROOF PLAN ELECTRICAL PLANS
- MECHANICAL PLANS
- FOUNDATION PLAN S-1
- SHEARWALL & HOLDDOWN PLAN S-3 ROOF FRAMING PLAN SD-1 STRUCTURAL DETAILS
- SD-2 STRUCTURAL DETAILS SD-3 STRUCTURAL DETAILS

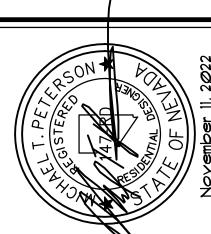

Date Description

eptember 2, 2021 M.T.P Thecked By | Project No. M. T. P. 2229

> **COVER SHEET** AND

Sheet Number

SITE PLAN


A-1


Final Submittal

SITE PLAN 049 - 040 - 08

6275 ROCK FARM ROAD

1''=20'-0''

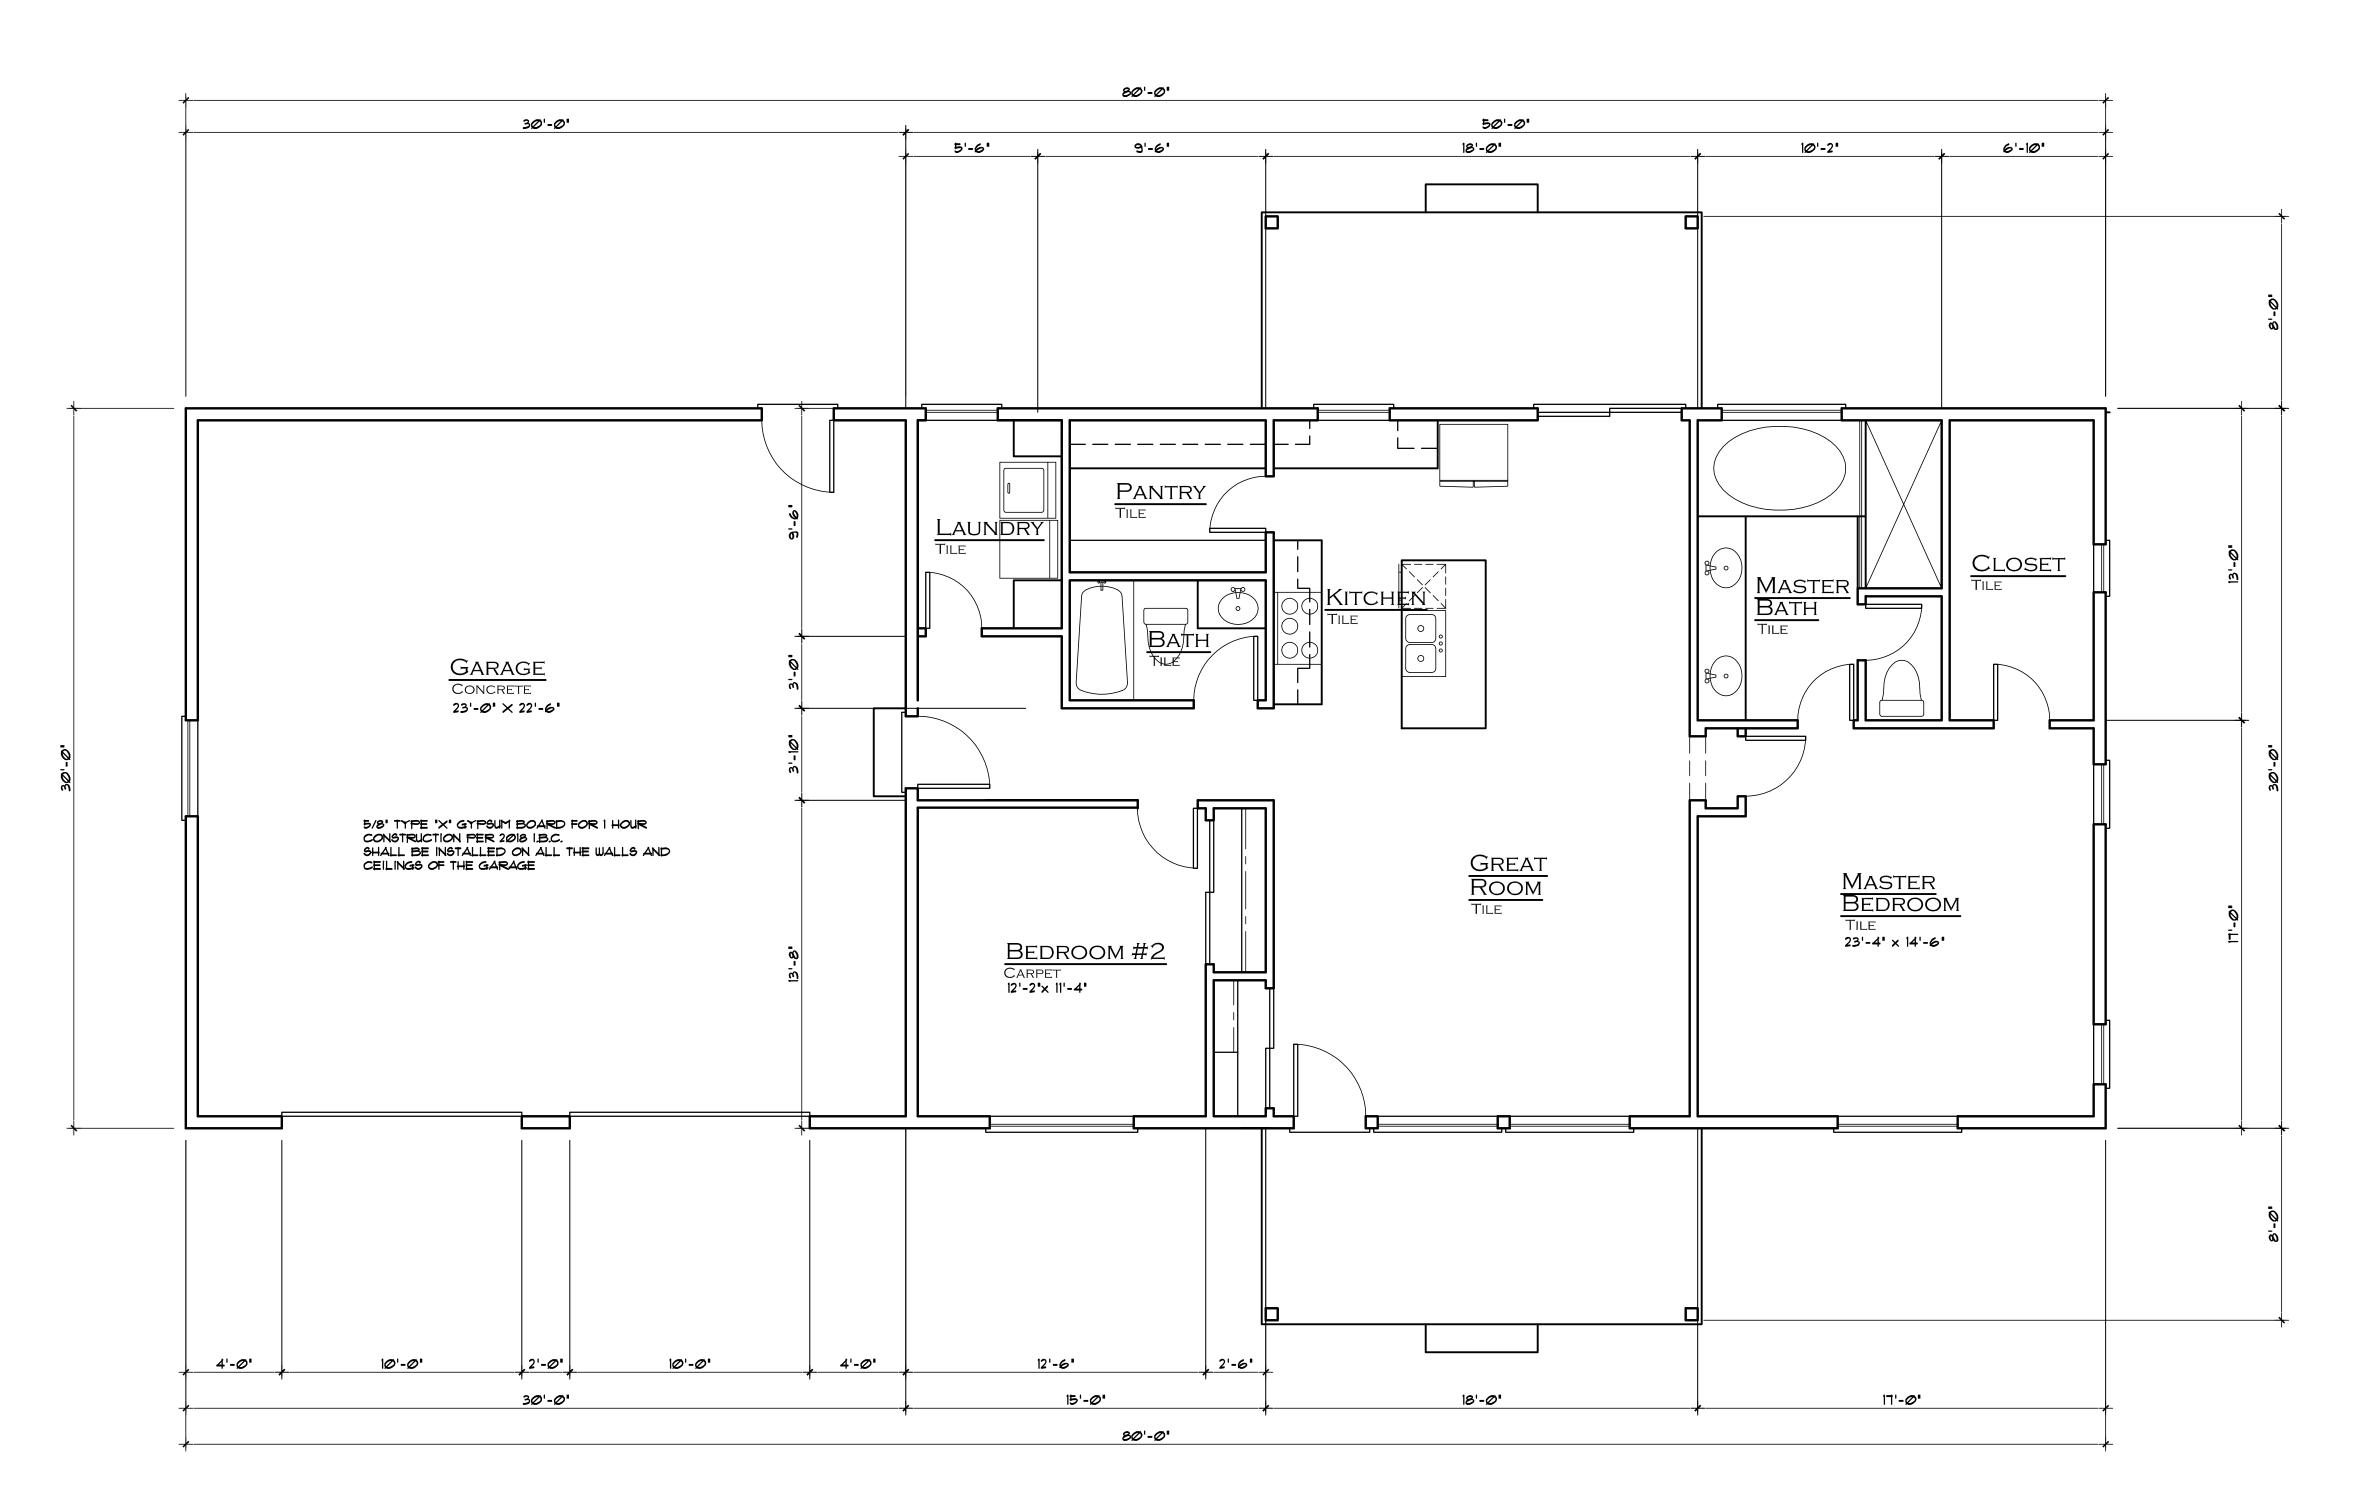

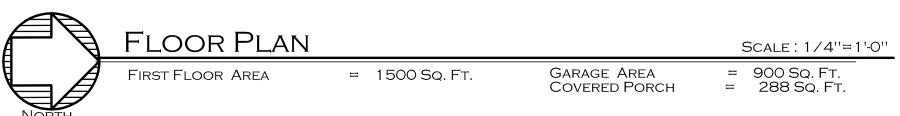

TYPICAL NOTES:

- 1. ALL EXTERIOR WALLS SHALL BE 2x6 @ 16" O.C. W/ R-21 FIBERGLASS BATT INSULATION W/ PAPER
- 2. NON LOAD BEARING INTERIOR WALLS SHALL BE 2x4 @ 16" O.C. TYP. U.N.O.
- 3. BATHROOM WALLS SHALL RECEIVE FIBERGLASS BATT SOUND INSULATION (TYP.)
- 4. ALL CEILINGS SHALL BE +9'-1" +/- MATCH EXISTING PLATE.
- 5. PROVIDE R-3 INSULATION ON ALL HOT WATER PIPES
- IN CRAWL SPACE. 6. SEE HEAT LOSS CALCULATIONS PER RESCHECK
- COMPLIANCE FOR MIN. WINDOW AND DOOR PERFORMANCE SPECIFICATIONS, AND FOR MECH. REQUIREMENTS. 7. AIR LEAKAGE AND SEALING MUST BE TESTED AND MEET OR
- BE LEESS THAN 5 AIR EXCHANGES PER HOUR IN ACCORDANCE WITH THE ADOPTED NORTHERN NEVADA AMENDMENTS TO THE 2018 IECC.
- 8. ATTIC ACCESS DOOR OR COVER TO TO BE INSULATED TO THE SAME EVEL AS THE ATTIC INSULATION. PROVIDE WEATHER STRIPPING FOR THE ACCESS DOOR OR COVER. PER 2018 IECC SECTION 402.2.3
- 9. SUPPLY DUCTS IN THE ATTIC TO BE INSULATED TO A MIN. OF R-8. ALL OTHER DUCTS TO BE INSULATED TO A MIN. OF R-6.
- 10. WALL AREAS IN TUBS AND SHOWERS SHALL BE CONSTRUCTED IN ACCORDANCE WITH 307.2 OR OTHER NON PERMIABLE MATERIALS TO THE HEIGHT OF 72" ABOVE THE TUB OR SHOWER FINISH, FLOOR.

ENERGY NOTES:


- I. A PERMANENT CERTIFICATE SHALL BE COMPLETED AND LOCATED IN AN APPROVED LOCATION THE LISTS THE PREDOMINANT R-VALVES OF THE INSULATION INSTALLED IN THE CEILING / ROOF, WALLS, FOUNDATION AND DUCTS OUTSIDE CONDITIONED SPACES, AND U-FACTORS FOR FENESTRATION.
- UNCONDITIONED SPACES (ATTIC) SHALL BE WEATHER STRIPPED AND INSULATED TO A LEVEL EQUIVALENT TO THE INSULATION ON THE SURROUNDING SURFACES.


2. THE ATTIC ACCESS DOOR FROM THE CONDITIONED SPACE TO

3. THE AIR BARRIER SHALL BE VERIFIED BY A BLOWER DOOR TEST. PER IECC R402.4.1.1

PLUMBING NOTES:

- HOSE BIBS SHALL BE PROVIDED WITH AN ATMOSPHERE OR PRESSURE TYPE VACUUM BREAKER.
- 2. THE WATER HAMMER ARRESTOR ARE REQUIRED AT THE QUICK-CLOSING VALVES, I.E., DISHWASHER & CLOTHES WASHER
- 3. THE REQUIRED TEMPERATURE LIMITING DEVICE FOR BATHTUBS AND SHOWERS SHALL BE SET AT 120°F.
- BACKWATER VALVE IS REQUIRED TO PROTECT PLUMBING FIXTURES THAT ARE LOCATED BELOW THE ELEVATION LEVEL OF THE NEAREST MAN HOLE COVER. FIXTURES THAT ARE ABOVE THE ELEVATION LEVEL OF THE MANHOLE COVER SHALL NOT DISCHARGE THROUGH THE BACKWATER VALVE.
- 5. JETTED TUBS SHALL HAVE A 12" x 12" ACCESS OPENING. IF THE PUMP IS LOCATED WITHING 2' FROM THE ACCESS OPENING THE OPENING SHALL BE 18" x 18"
- 6. HOT WATER PIPING SHALL BE INSULATED WITH R-3 MIN.
- 1. PROVIDE A WATER PRESURE REGULATOR IN ACCORDANCE WITH 2018 UPC WHEN CITY WATER SUPPLY EXCEEDS 80 PSI.

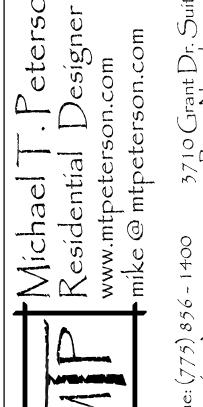


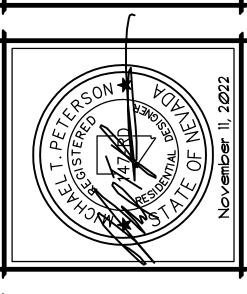

Mark Date Description September 2, 2021 hecked By | Project No. M. T. P. 2229

FLOOR PLAN Sheet Number **A-2**


Final Submittal

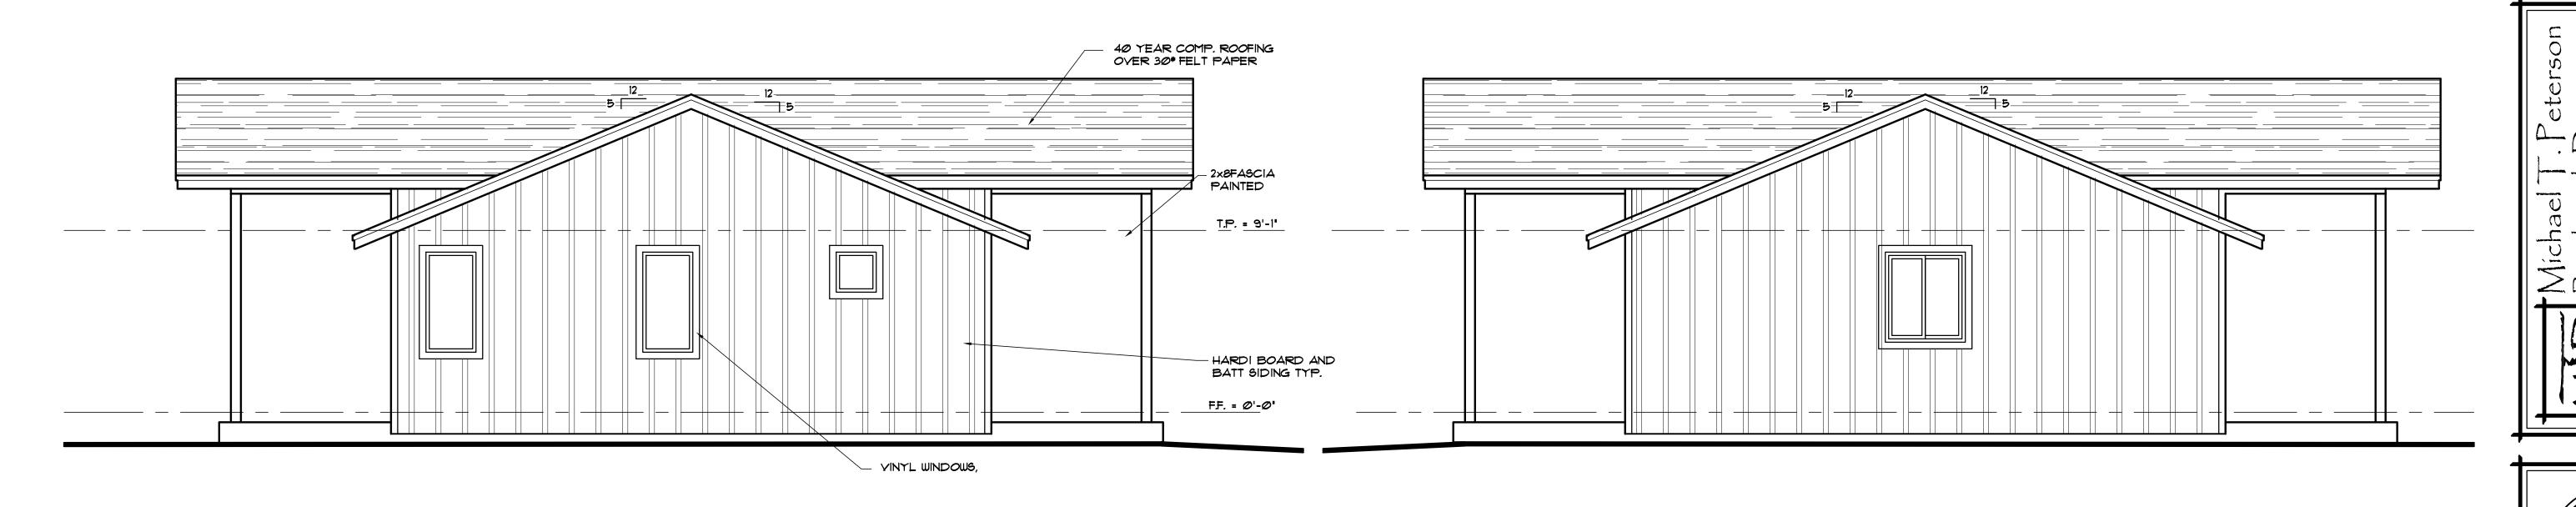


EAST ELEVATION SCALE: 1/4"=1'-0"

EAST ELEVATION

SCALE: 1/4"=1'-0"

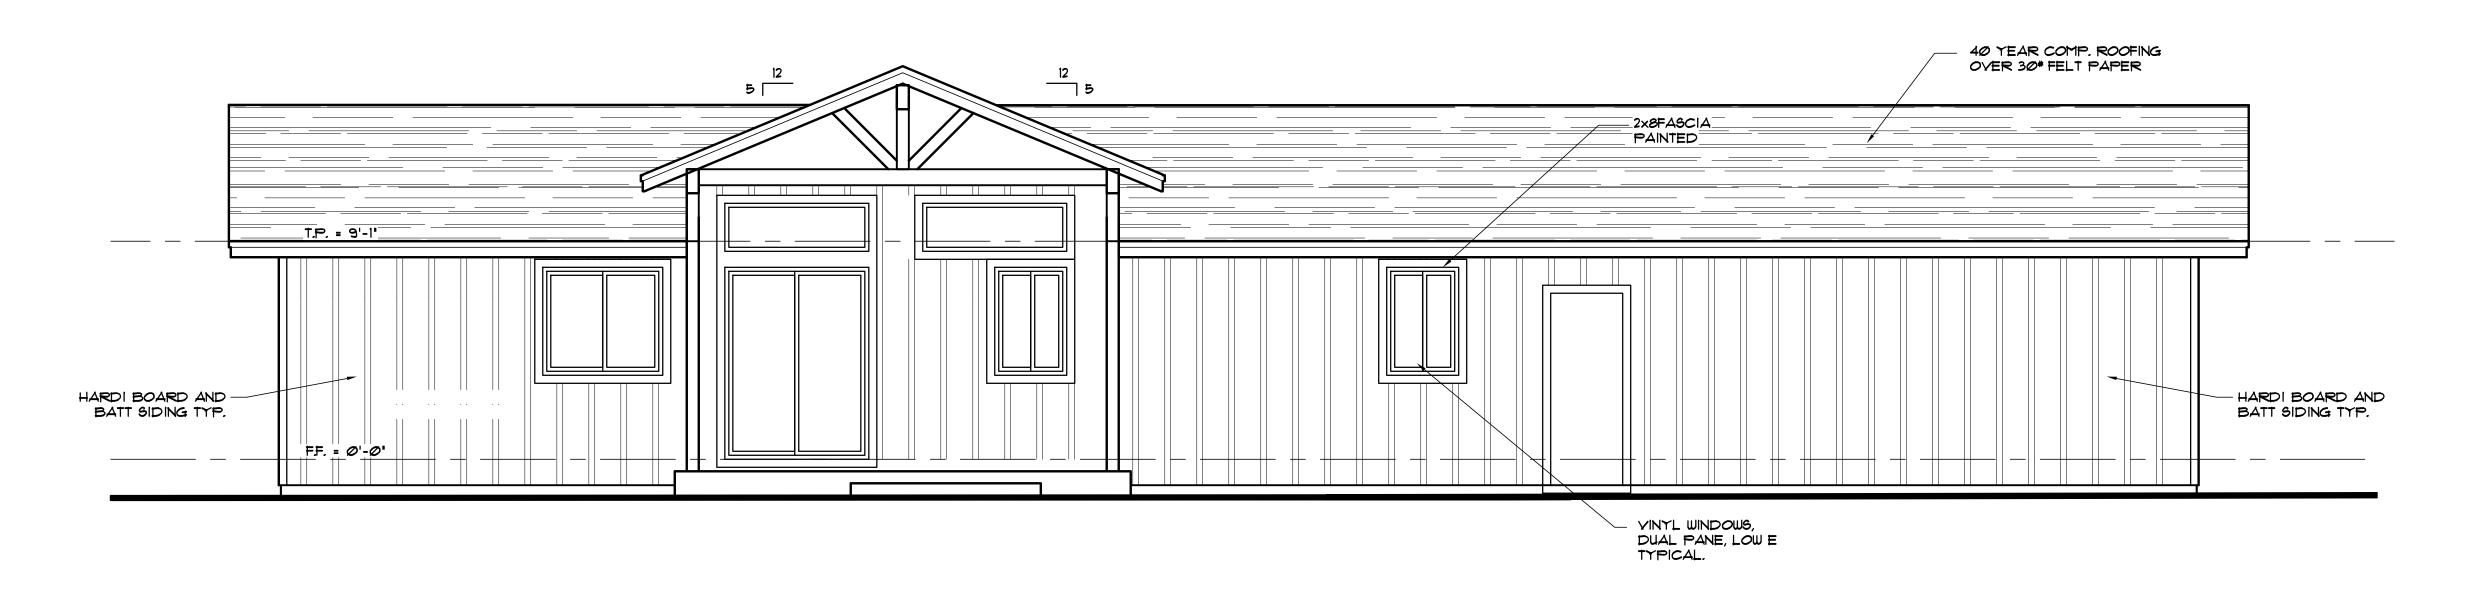

EAST ELEVATION SCALE: 1/4"=1'-0"

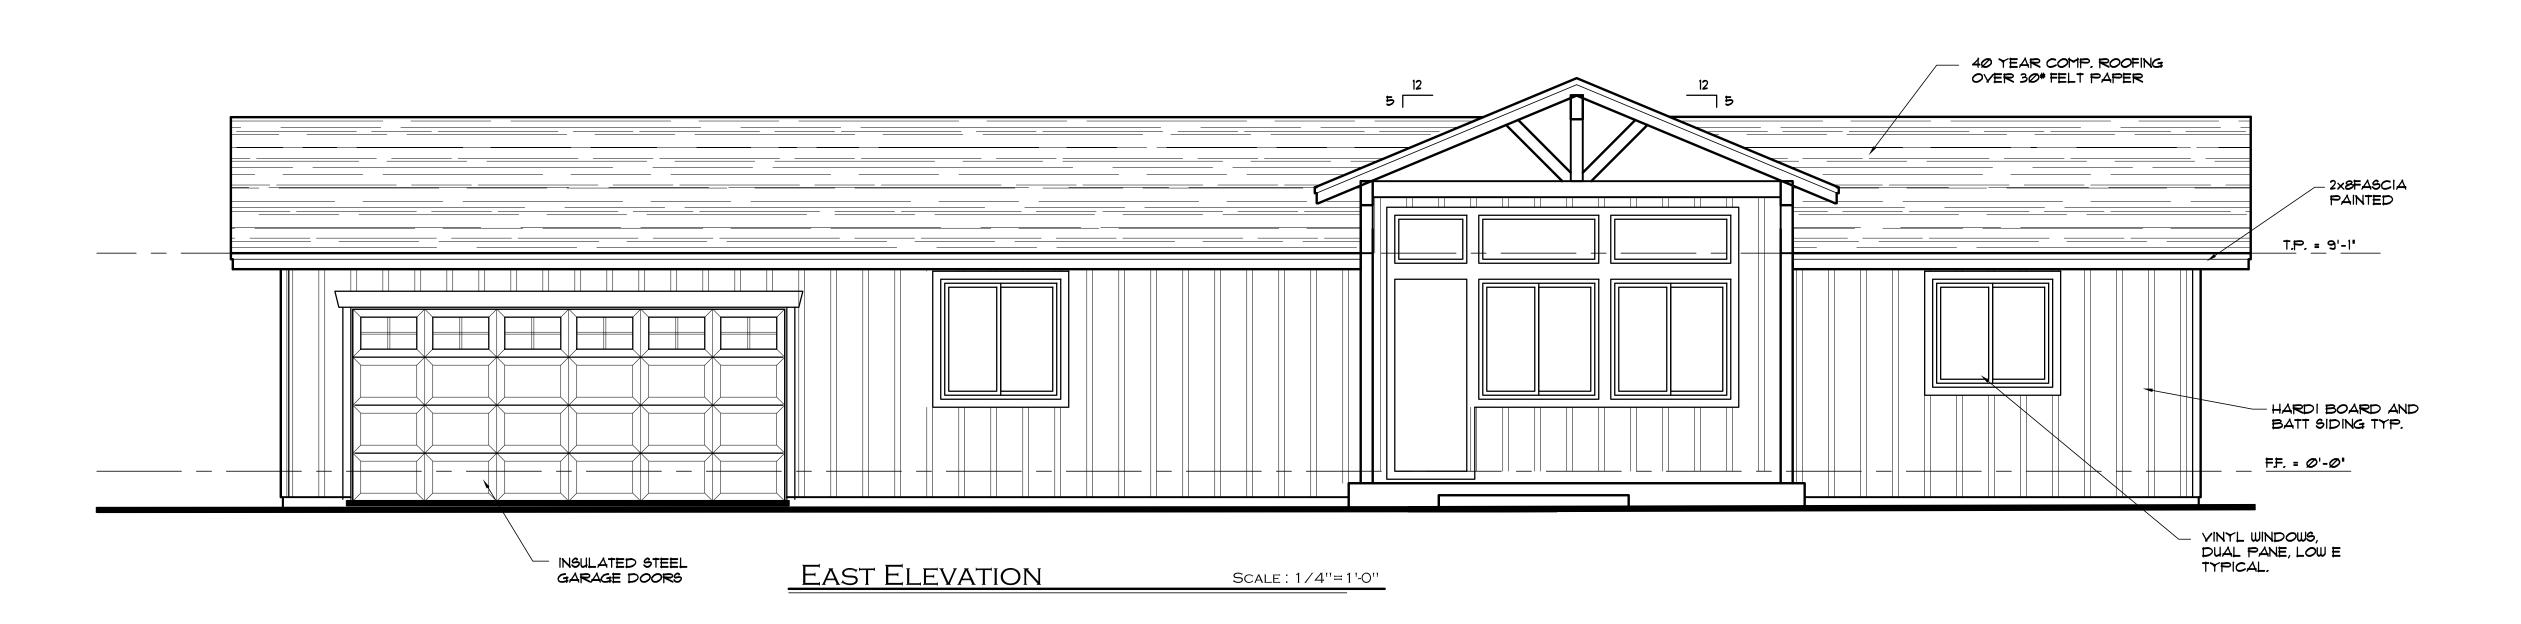

A New Inlaw Quarters
For
For
Jean & Lori Fuselier
6275 Rock Farm Road
Ren Mandagett

Revisions
Mark Date Description

Drawn By Date
M.T.P. September 2, 2022

Checked By Project No.
M.T.P. 2229

Sheet Title

EXTERIOR

ELEVATIONS

Sheet Number

A-3

Final Submittal